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**HALIBURTON COMMERCIAL DEVELOPMENT  
5065 COUNTY ROAD 21  
COUNTY OF HALIBURTON  
FUNCTIONAL SERVICING REPORT**

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Prepared by:

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November 2024  
20-11523M

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**TABLE OF CONTENTS**

<b>1.0 INTRODUCTION.....</b>	<b>1</b>
1.1 Background.....	1
1.2 Purpose and Scope .....	1
<b>2.0 REFERENCE REPORTS.....</b>	<b>1</b>
<b>3.0 EXISTING CONDITIONS .....</b>	<b>1</b>
3.1 General .....	1
<b>4.0 PROPOSED DEVELOPMENT.....</b>	<b>3</b>
<b>5.0 SANITARY SEWERS .....</b>	<b>3</b>
5.1 Existing Infrastructure .....	3
5.2 Proposed Servicing Strategy .....	3
<b>6.0 Watermain.....</b>	<b>4</b>
6.1 Analysis of On-site Fire Protection.....	4
<b>7.0 SUMMARY AND CONCLUSIONS.....</b>	<b>4</b>

**APPENDICES**

Appendix A – Design Calculations  
Appendix B – Drawings

**HALIBURTON COMMERCIAL DEVELOPMENT  
5065 COUNTY ROAD 21, COUNTY OF HALIBURTON  
FUNCTIONAL SERVICING REPORT**

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## **1.0 INTRODUCTION**

### **1.1 Background**

The property owner is proposing to construct a commercial development on an unaddressed lot to the rear of 5065 County Road 21, in the County of Haliburton. The property is approximately 3.67 ha in size and is legally described as Parts 1 and 2, Plan 19R-7918, in the Geographic Township of Dysart, County of Haliburton. The property is bounded by Mallard Road to the North-east, vacant forested lands to the west, and commercial development to the south and east. (see Figure 1).

Development on the property is proposed to include industrial or commercial buildings with associated surface parking. The development plans for each individual lot are unknown at this stage and will be determined as lots are sold and developed. Access to the site will be provided by the extension of a proposed road off of Mallard Road.

### **1.2 Purpose and Scope**

Pinestone Engineering Ltd (PEL) has been retained by the developer to prepare a functional servicing report (FSR) in support of the current planning applications. The report describes the proposed servicing strategy for the site.

## **2.0 REFERENCE REPORTS**

The following reports and studies have been used for reference in the preparation of this Servicing and Storm Water Management Plan:

- i) *Ministry of the Environment's Design Guidelines for Sewage Works, 2008.*


## **3.0 EXISTING CONDITIONS**

### **3.1 General**

The subject site is approximately 3.67 hectares in size. Access is provided by a gravel driveway extending off of Mallard Road. The majority of the site is currently vacant and heavily vegetated with grasses and trees. A gravel yard and parking area are currently constructed in the southern portion of the site.

There is a well-defined intermittent watercourse that crosses the center of the property, flowing from west to east. An existing 500mm dia. culvert and swale convey the watercourse to adjacent lands east of the property.

Currently, water and sewage services are not available on the site.

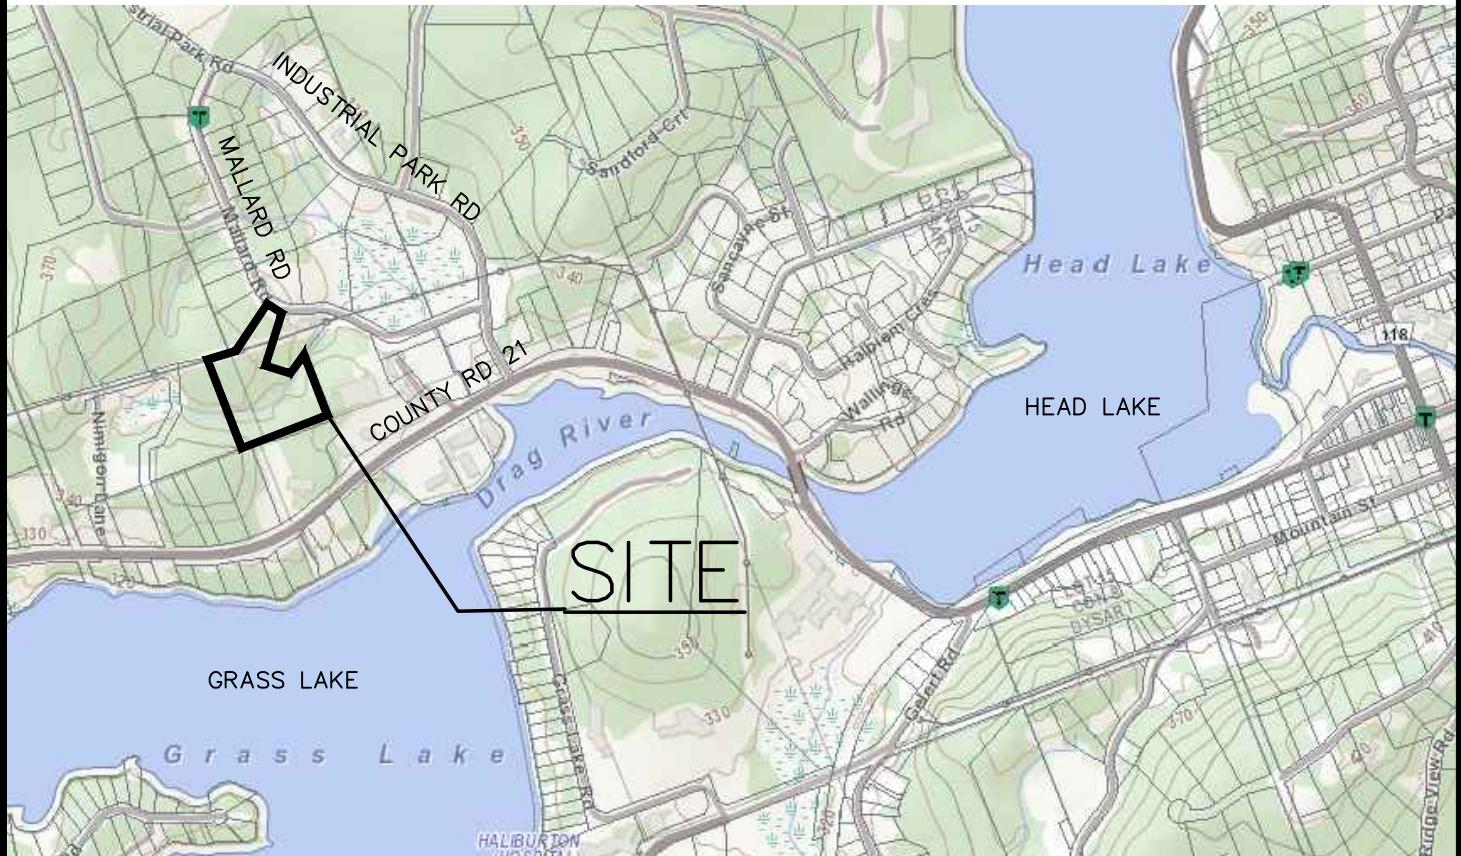

**PEL**  
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HALIBURTON COMMERCIAL DEVELOPMENT

**LOCATION PLAN**

DATE: NOVEMBER 2024	SCALE: N.T.S.	PROJECT No. 20-11523-M	FIGURE No. FIGURE 1
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**HALIBURTON COMMERCIAL DEVELOPMENT  
5065 COUNTY ROAD 21, COUNTY OF HALIBURTON  
FUNCTIONAL SERVICING REPORT**

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## **4.0 PROPOSED DEVELOPMENT**

Development on the property is proposed to include industrial or commercial buildings with associated surface parking. The site plan configurations for each lot are unknown at this stage and will be determined as individual lots are sold and developed. Access to the site will be provided by the extension of a proposed road off of Mallard Road. It is anticipated that Site Plan Approval (SPA) will be required for each individual lot development.

Drainage from the proposed buildings and surface parking facility of each individual lot will be directed to a parking lot ponding storage area or storm water management pond to attenuate peak flows. Where parking lot storage is utilized, site drainage will be directed to an oil/grit separator unit designed to provide an enhanced level of quality control for each lot, prior to discharging to the proposed municipal ditches and ultimately to Grass Lake.

Sanitary servicing is available on County Road 21 and will be extended to the site via a proposed easement crossing the Curry Chevrolet Buick GMC Ltd property. A preliminary plan and profile for the sanitary sewer extension through the proposed easement and private condominium road is shown on drawings PP-1 and PP-2.

Water servicing will be provided by individual wells.

## **5.0 SANITARY SEWERS**

### **5.1 Existing Infrastructure**

There is an existing 250mm dia. PVC sanitary sewer installed on County Road 21. The sewer flows north-east on County Road 21. The Municipality of Dysart is to confirm available residual system capacity of the existing sanitary sewer system based on the anticipated sewage flows outlined in this report.

### **5.2 Proposed Servicing Strategy**

The proposed site development will be serviced by gravity sanitary sewers to be extended to the site from County Road 21 via a proposed easement crossing the Curry Chevrolet Buick GMC Ltd property. A preliminary plan and profile for the sanitary sewer extension through the proposed easement and private condominium road is shown on drawings PP-1 and PP-2.

The proposed peak sanitary design flows for the development were calculated using sewage flow rates, in accordance with MECP guidelines for sewage works, as follows:

- 1.0 L/s/ha for industrial development

The total proposed design flow for the development was determined to be 4.00L/sec. A copy of the sanitary sewer design sheet is included in Appendix B. The capacity of the existing immediate downstream reach of 250mm dia. sanitary sewer is approximately

**HALIBURTON COMMERCIAL DEVELOPMENT  
5065 COUNTY ROAD 21, COUNTY OF HALIBURTON  
FUNCTIONAL SERVICING REPORT**

---

101.2 L/sec and the proposed design flow is expected to utilize 3.95% of the total pipe capacity in this reach.

## **6.0 WATERMAIN**

There is no municipal water treatment or distribution system within the Village of Haliburton. Individual wells will be required on each lot to supply domestic water, with on-site treatment provided based on the chemistry of the source water.

### **6.1 Analysis of On-site Fire Protection**

The Dysart Fire Department is primarily comprised of volunteer firefighters. Most of their firefighting operations are made up of drafting, water shuttling and pump relaying. Grass Lake is a natural water source that is in close proximity to the proposed building sites and available as a drafting location. Alternatively on-site tank storage with dry hydrant connection could be provided on each lot, with the storage volume based on the size and type of building proposed and the Fire Underwriters Survey calculation guide.

## **7.0 SUMMARY AND CONCLUSIONS**

The findings of this report are summarized as follows:

- Gravity sewer can be extended from County Road 21 to service the development.
- Wells will be required on each lot to supply domestic water with on-site treatment provided.
- Fire protection can be provided by drafting or dry-hydrant connections.

It is recommended that this report and drawings be submitted to the County of Haliburton and the Municipality of Dysart et al for review and approval.

All of which is respectfully submitted.

**PINESTONE ENGINEERING LTD.**



Lauren Trividic, P.Eng.



**HALIBURTON COMMERCIAL DEVELOPMENT  
5065 COUNTY ROAD 21, COUNTY OF HALIBURTON  
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**APPENDIX A**

**Design Calculations**



Haliburton Commercial Development Municipality of Dysart				<b>SANITARY SEWER DESIGN SHEET</b> <b>ENGINEERING AND PUBLIC WORKS</b> Drainage Area Plan No: SAN - 1										<b>Design Parameters</b> Average Daily Flow Residential 0.0052 L/s/c Commercial 1.5 L/s/ha Industrial 1.0 L/s/ha Inst. / School 2.5 L/s/ha Mannings "n" 0.0130 Min. Velocity 0.60 m/sec Max. Velocity 3.0 m/sec Residential Harmon Peaking Factor (F)																									
Project Number:	20-11523M	Date:	January 14, 2025																																				
Design By:	LT	Checked By:	LT																																				
File:	Z:\Project Documents\11500 - 11749\11523M Campbell Commercial\FSR\Sanitary Sewer Design Sheet - Revised Jan 2025.xls																																						
LOCATION				RESIDENTIAL AREAS and POPULATION				SCHOOL, INSTITUTIONAL			COMMERCIAL			INDUSTRIAL			INFILTRATION			DESIGN																			
STREET	AREA NO.	MANHOLE LOCATION		AREA	UNITS	POPUL. CUMUL. POPUL.	PEAK FACTOR "F"	PEAK RES. FLOW	HECTARES AND FLOW OF EACH ZONING												TOTALS C-I FLOW	AREA	CUMUL AREA	INFIL FLOW	TOTAL VOLUME FLOW														
		FROM MH	TO MH						2.50 L/s/ha	1.50 L/s/ha	1.00 L/s/ha	AREA	CUMUL AREA	PEAK FLOW	AREA	CUMUL AREA	PEAK FLOW	AREA	CUMUL AREA	PEAK FLOW																			
		ha	3.5pp/unit			1000s	1000s	L/sec	ha	ha	L/sec	ha	ha	L/sec	ha	ha	L/sec	L/sec	ha	ha	L/sec		L/sec	m	%	mm	L/sec.	m/s	m/s										
LOT 1	301	1	2			0.000	0.000	4.5	0.0000									0.82	0.82	0.8200	0.8200	0.88	0.88	0.2464	1.0664	32.0	4.80	200	71.8213	2.287	0.820								
LOT 2	302	2	3			0.000	0.000	4.5	0.0000									0.47	1.29	1.2900	1.2900	0.55	1.43	0.4004	1.6904	51.0	0.40	200	20.7330	0.660	0.397								
LOT 4	303	3	4			0.000	0.000	4.5	0.0000									0.64	1.93	1.9300	1.9300	0.70	2.13	0.5964	2.5264	36.0	0.40	200	20.7330	0.660	0.447								
LOTS 3&5	304	4	5			0.000	0.000	4.5	0.0000									1.14	3.07	3.0700	3.0700	1.19	3.32	0.9296	3.9996	28.0	0.40	200	20.7330	0.660	0.510								
		5	6			0.000	0.000	4.5	0.0000									0.00	3.07	3.0700	3.0700	0.00	3.32	0.9296	3.9996	36.0	0.40	200	20.7330	0.660	0.510								
		6	7			0.000	0.000	4.5	0.0000									0.00	3.07	3.0700	3.0700	0.00	3.32	0.9296	3.9996	34.0	0.40	200	20.7330	0.660	0.510								
		7	8			0.000	0.000	4.5	0.0000									0.00	3.07	3.0700	3.0700	0.00	3.32	0.9296	3.9996	33.0	0.40	200	20.7330	0.660	0.510								
		8	9			0.000	0.000	4.5	0.0000									0.00	3.07	3.0700	3.0700	0.00	3.32	0.9296	3.9996	47.0	0.40	200	20.7330	0.660	0.510								
		9	10			0.000	0.000	4.5	0.0000									0.00	3.07	3.0700	3.0700	0.00	3.32	0.9296	3.9996	36.0	0.40	200	20.7330	0.660	0.510								
		10	EX58			0.000	0.000	4.5	0.0000									0.00	3.07	3.0700	3.0700	0.00	3.32	0.9296	3.9996	50.0	2.90	250	101.2181	2.063	0.999								

**HALIBURTON COMMERCIAL DEVELOPMENT  
5065 COUNTY ROAD 21, COUNTY OF HALIBURTON  
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**APPENDIX B**


**Drawings**



The position of existing above ground and underground utilities and facilities are not necessarily shown on the drawings, and where shown, the accuracy of the position of such utilities and facilities is not guaranteed. Before starting work, the contractor shall confirm the exact location of all existing utilities and facilities, and shall assume all liability for damage to them.

Drawings shall not be used for construction unless sealed and signed. All work to be performed in accordance with the Occupational Health & Safety Act 1990.

Any errors and/or omissions shall be reported to Pinestone Engineering Ltd. without delay.

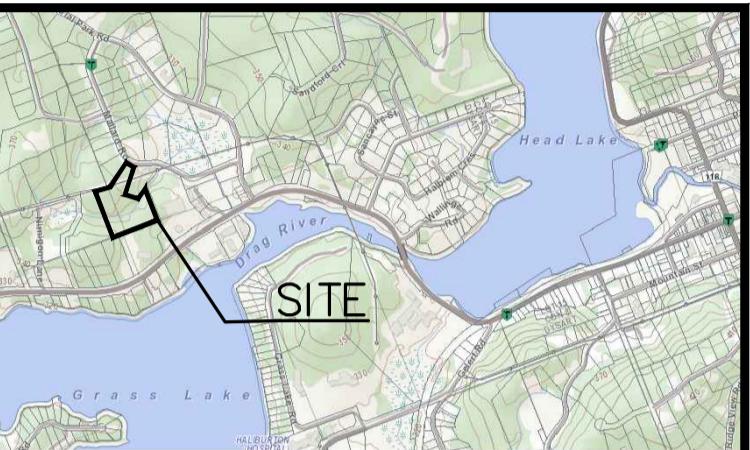


### KEY MAP NOTES

1. TOPOGRAPHIC SURVEY COMPLETED BY PINESTONE ENGINEERING, AUGUST 2020.

#### LEGEND

- PROPOSED SANITARY MANHOLE
- PROPOSED SANITARY SEWER
- SANITARY CATCHMENT BOUNDARY
- CATCHMENT NUMBER
- (CIRCLE) 301 0.88 AREA(ha)

NO. YY.MM.DD	REVISION	BY

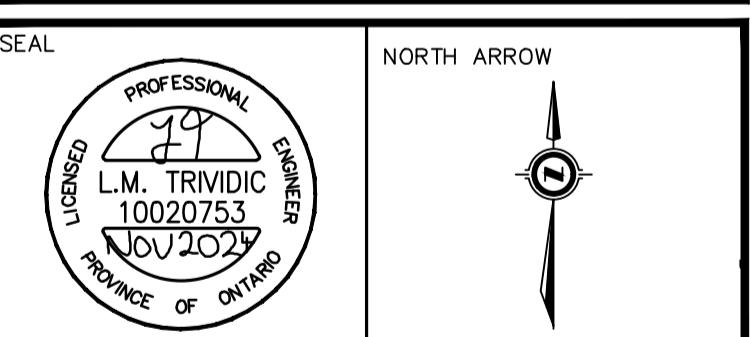


DESIGN BY:	T.H.
DRAWN BY:	G.N.
CHECKED:	T.H.
DATE:	NOVEMBER 2024
SCALE:	1:500



CLIENT/PROJECT

### HALIBURTON COMMERCIAL DEVELOPMENT

DRAWING TITLE  
**SANITARY DRAINAGE CATCHMENT  
PLAN**

PROJECT NO. 20-11523-M DRAWING NO. SAN-1 REVISION 0

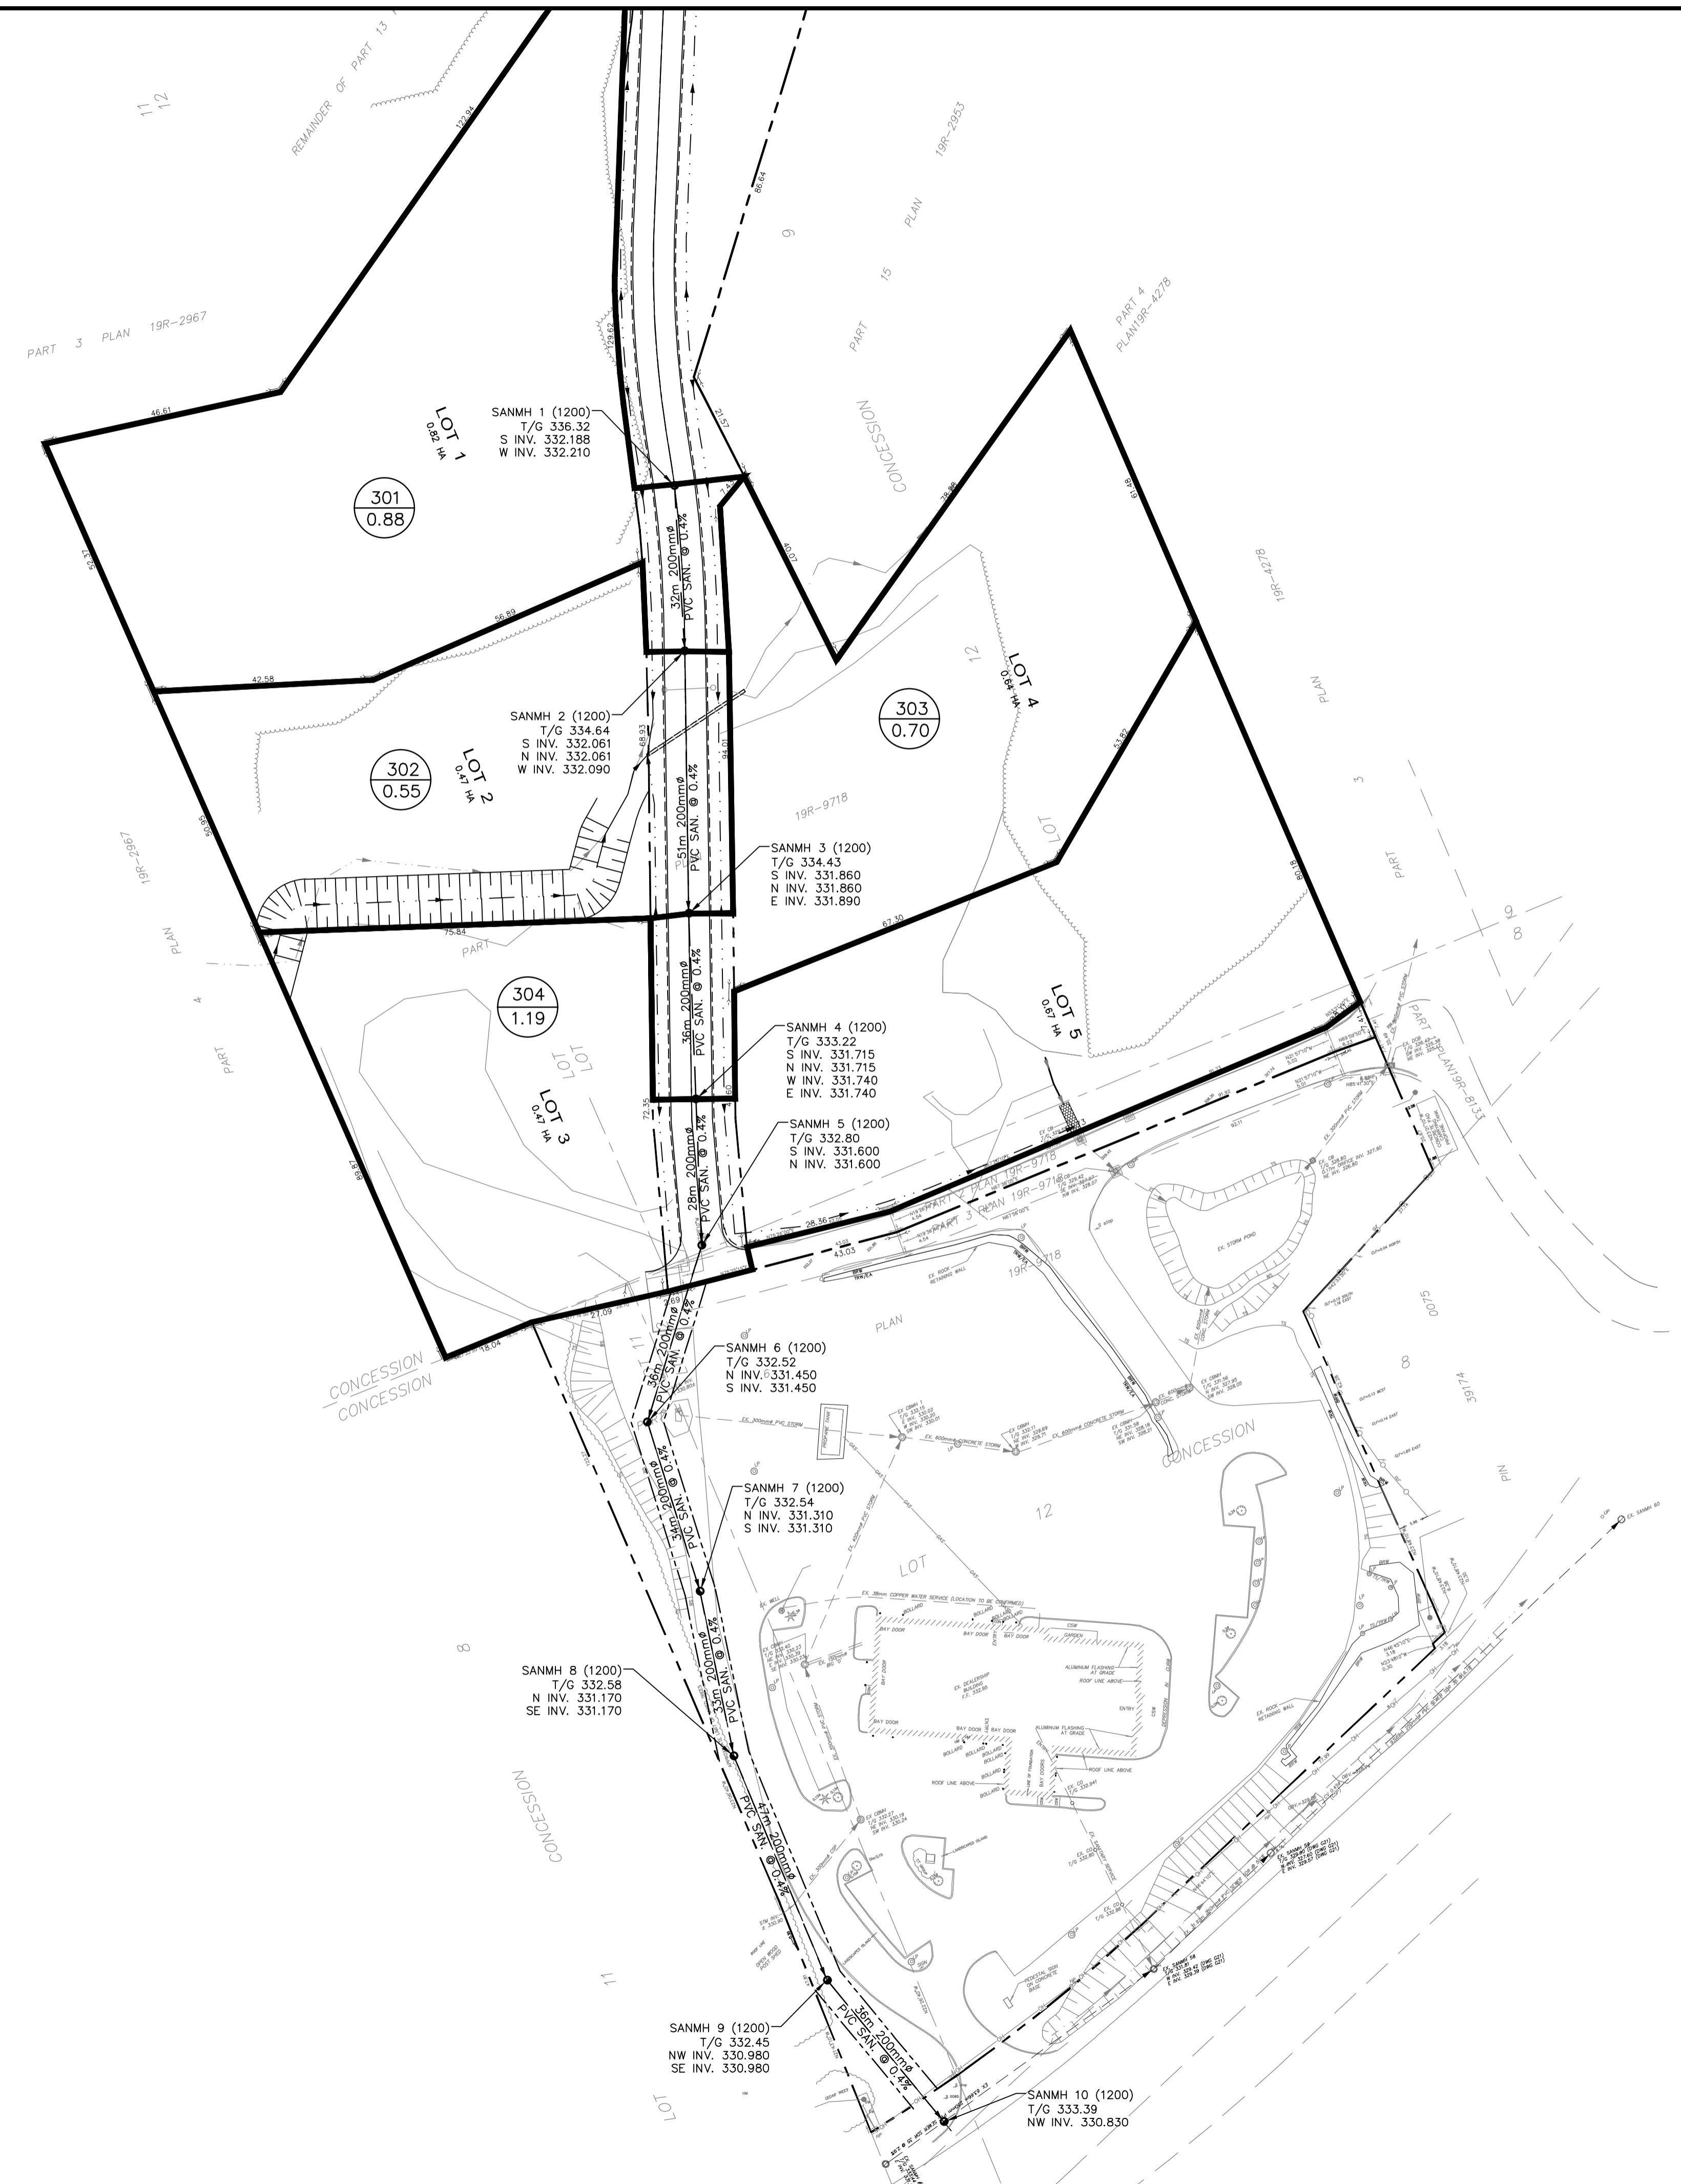

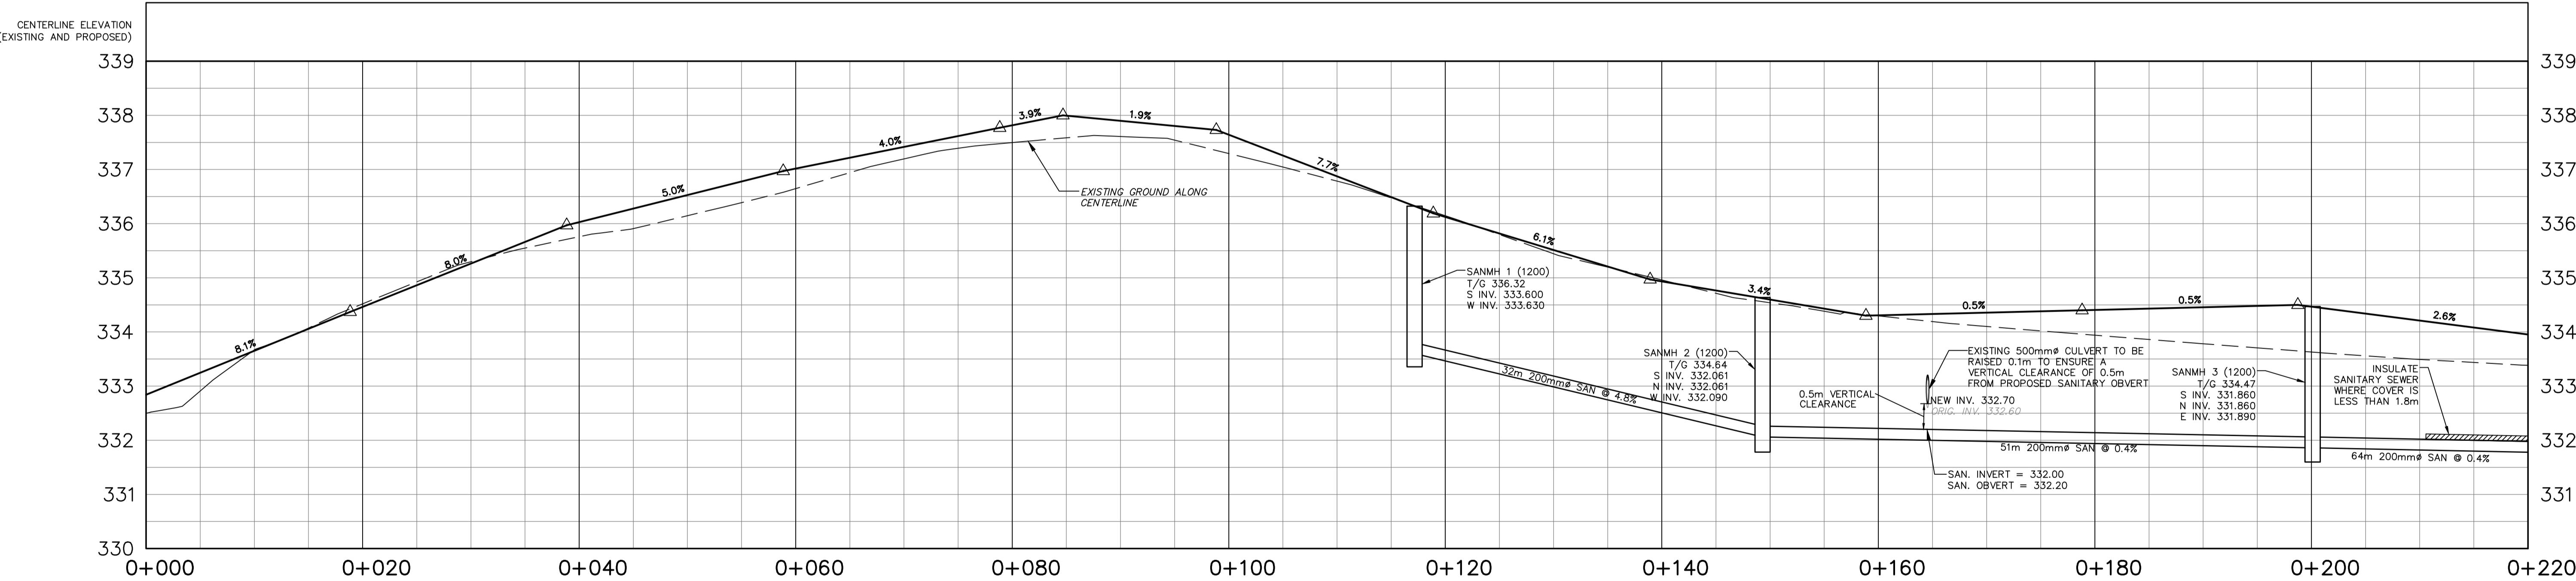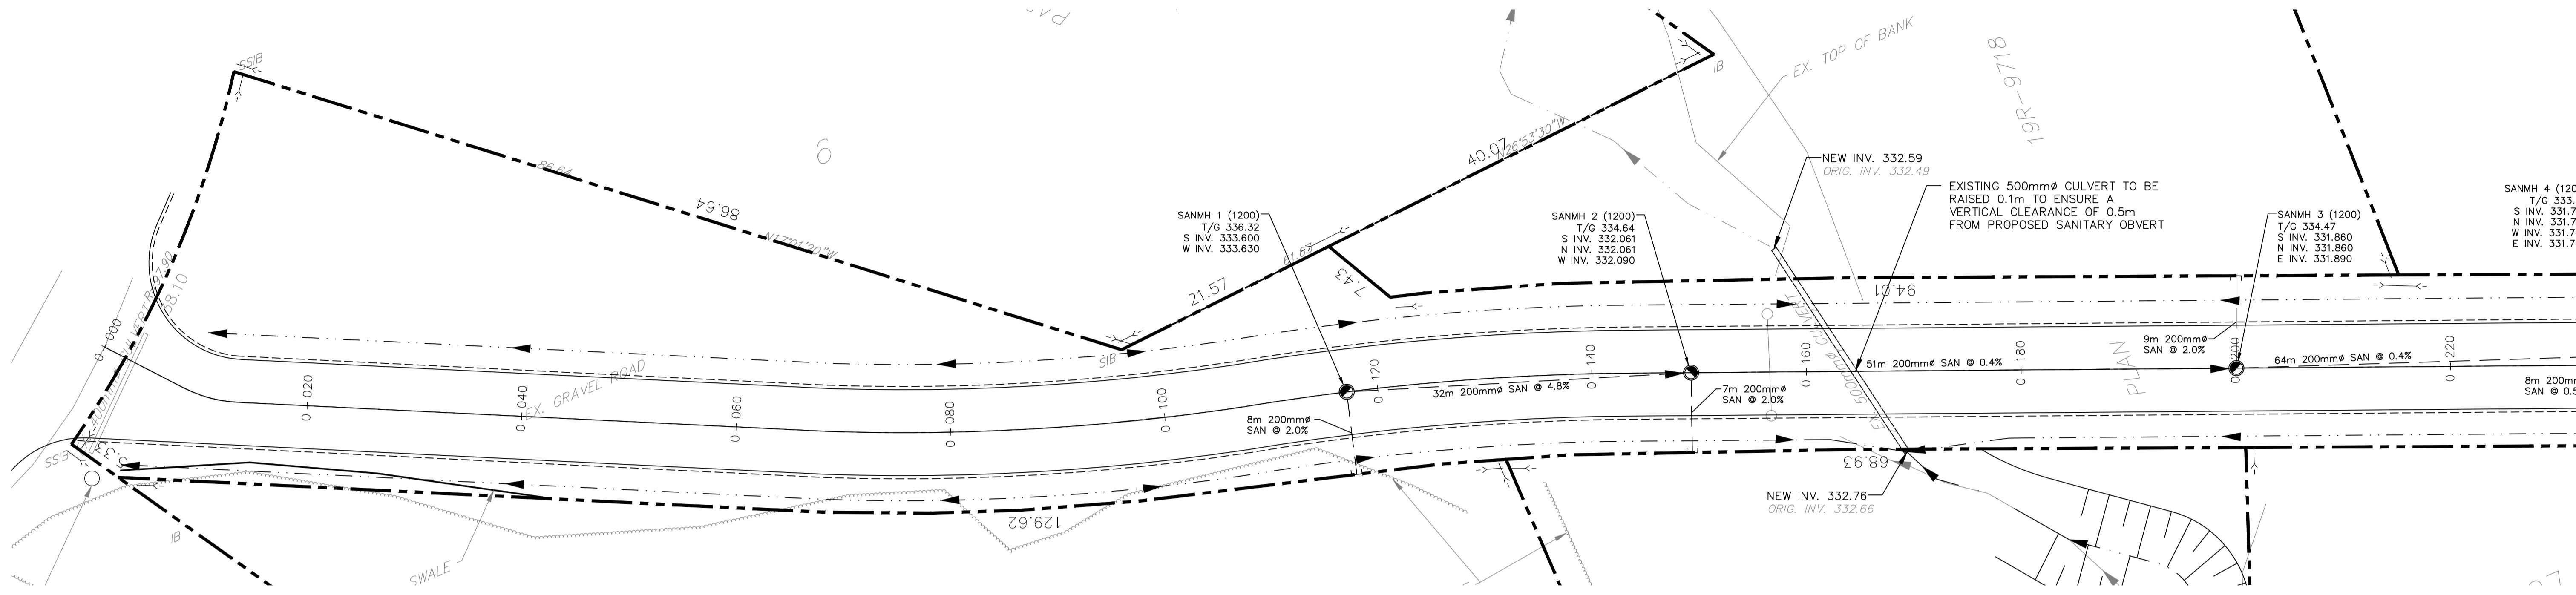

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PROFESSIONAL ENGINEER  
L.M. TOMIC  
100220/53  
JAN/25

DRAWN BY:  
G.N.  
L.T.

DESIGNED BY:  
L.T.

CHECKED BY:

NORTH ARROW

PROJECT:

HALIBURTON COMMERCIAL DEVELOPMENT

DRAWING:



PROPOSED SANITARY ALIGNMENT

STA. 0+000 TO 0+220

PP-1

1:300  
1:30  
NOVEMBER 2024  
1 25.01.10 REVISED PER TOWN COMMENTS  
NO. YY.MM.DD REVISION BY


PROJECT No.:  
20-11523-M  
DRAWING No.:  
PP-1

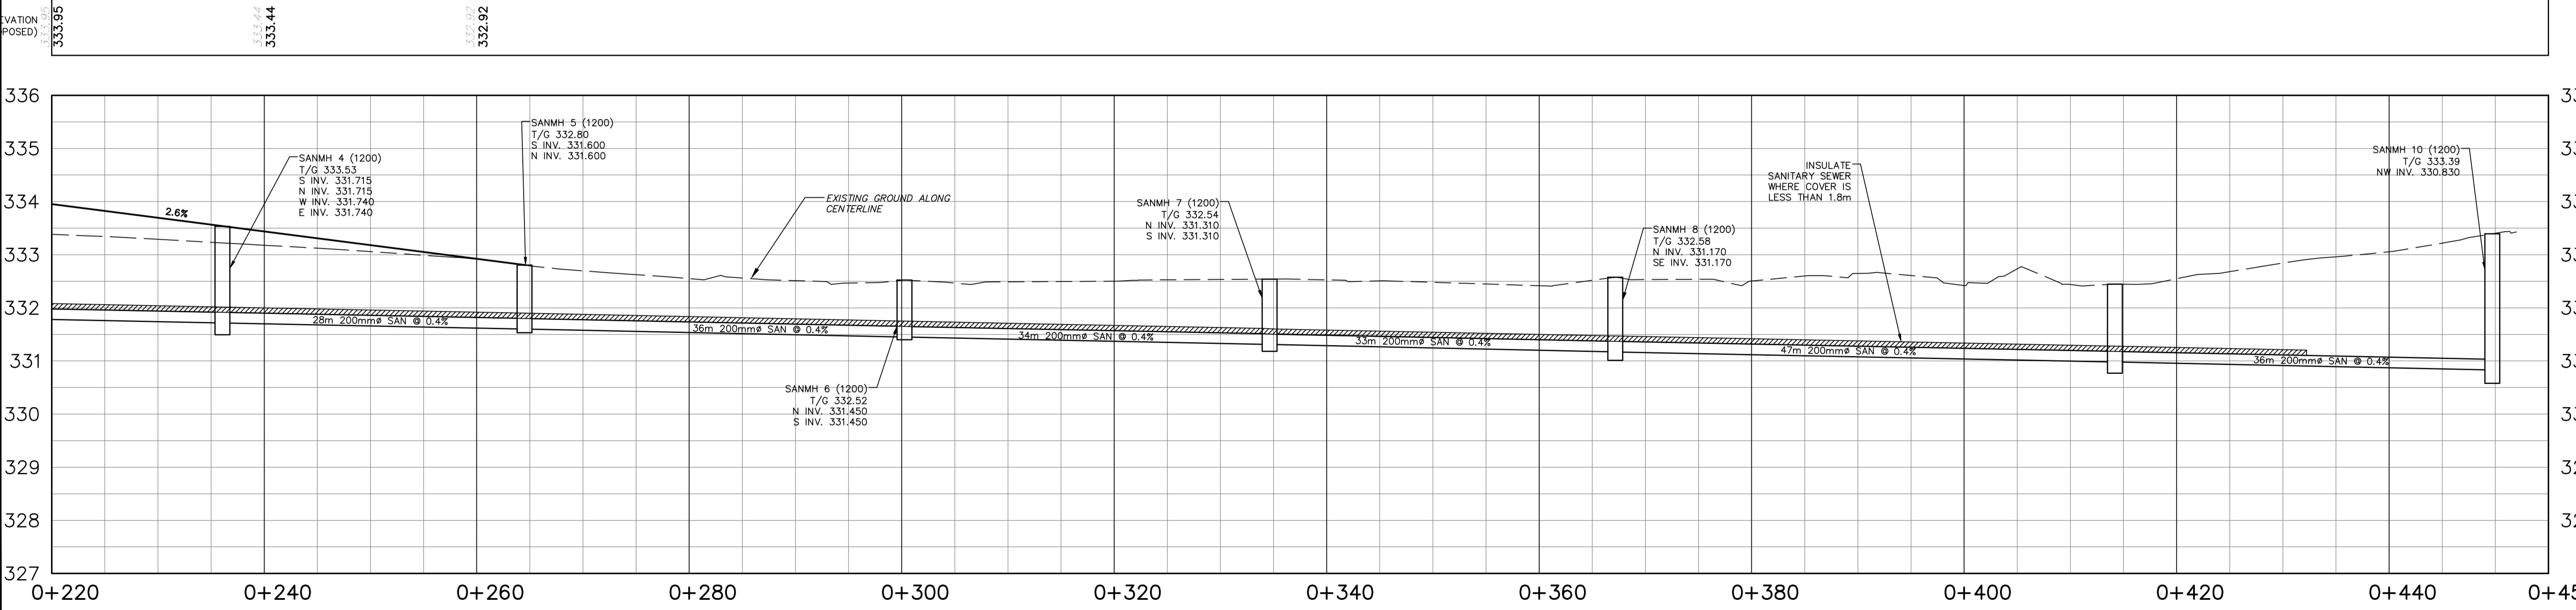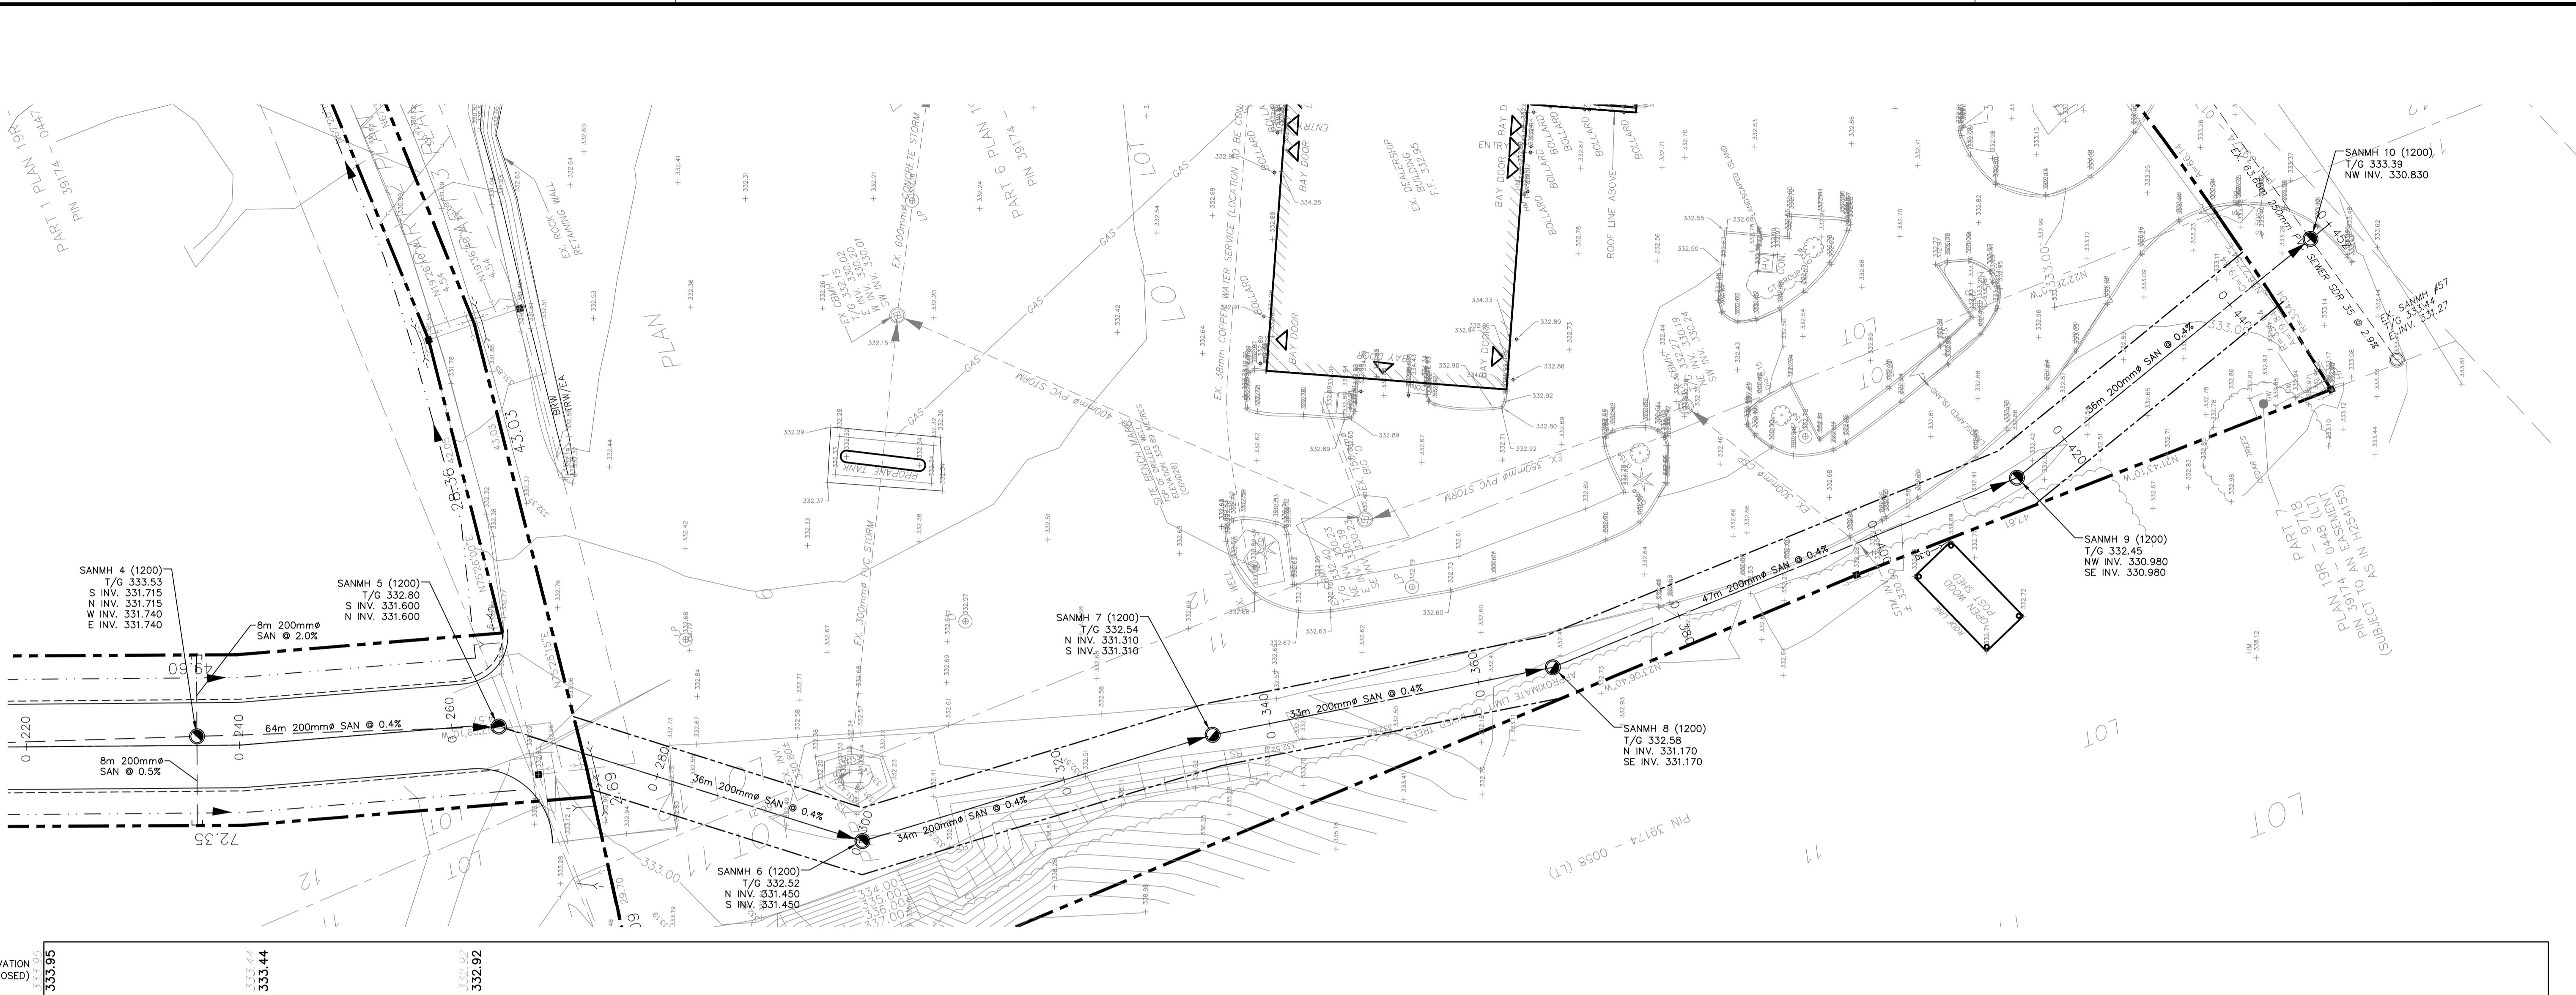

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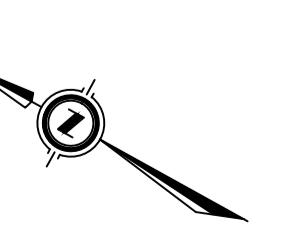
PROFESSIONAL ENGINEERS  
OF ONTARIO  
100207033

L.T.

G.N.

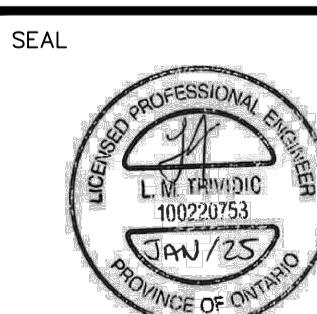L.T.

NORTH ARROW



PROJECT:

HALIBURTON COMMERCIAL DEVELOPMENT

DRAWING:

PROPOSED SANITARY ALIGNMENT  
STA. 0+220 TO STA. 0+455

PROJECT No. :  
20-11523-M

DRAWING No. :

PP-2